


THE GOVERNOR'S ACADEMY PEDESTRIAN WALKWAY

MIDDLE ROAD NEWBURY, MASSACHUSETTS MARCH 1, 2023

> **REV: MARCH 7, 2023** REV: MARCH 15, 2023

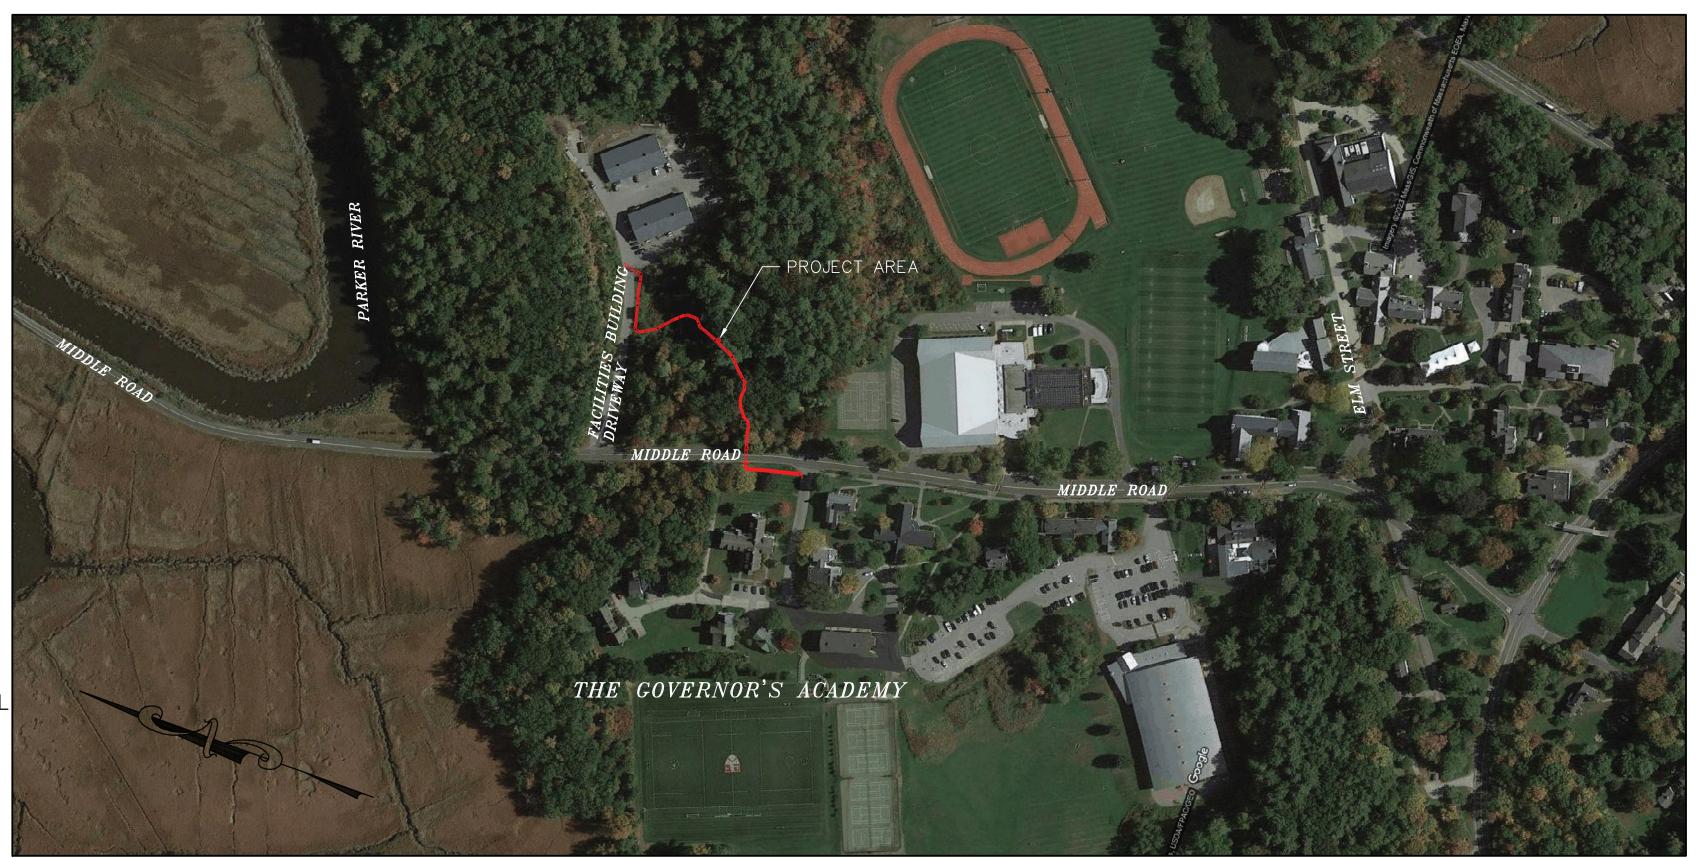

LOCUS MAP SCALE: 1"=200'

PROJECT LOCATION THE RESIDENTIAL-AGRICULTURAL

ZONING DISTRICT

R15-0-11: 313 NEWBURYPORT TURNPIKE

R15-0-5: 306 MIDDLE ROAD

OWNER/APPLICANT

THE GOVERNORS ACADEMY 1 ELM STREET BYFIELD, MA 01922

SITE CIVIL ENGINEER CIVILWORKS NEW ENGLAND

181 Watson Road, P.O. Box 1166 Dover, New Hampshire 03820 (603) 749-0443


LAND SURVEYOR


MCENEANEY SURVEY ASSOCIATES OF NEW ENGLAND P.O. BOX 681


24 CHESTNUT STREET DOVER, NH 03820 (603) 742-0911

COMMON	MARK E. BEAUDRY CIVIL No. 38189 REGISTERED SS DIVIL	New Series
	West	3/1

SHEET SHEET INDEX **COVER SHEET** SITE PLAN PLAN & PROFILE C-2 WETLAND REPLICATION PLAN C-3 **EROSION & SEDIMENT CONTROL PLAN** DETAIL SHEET 1

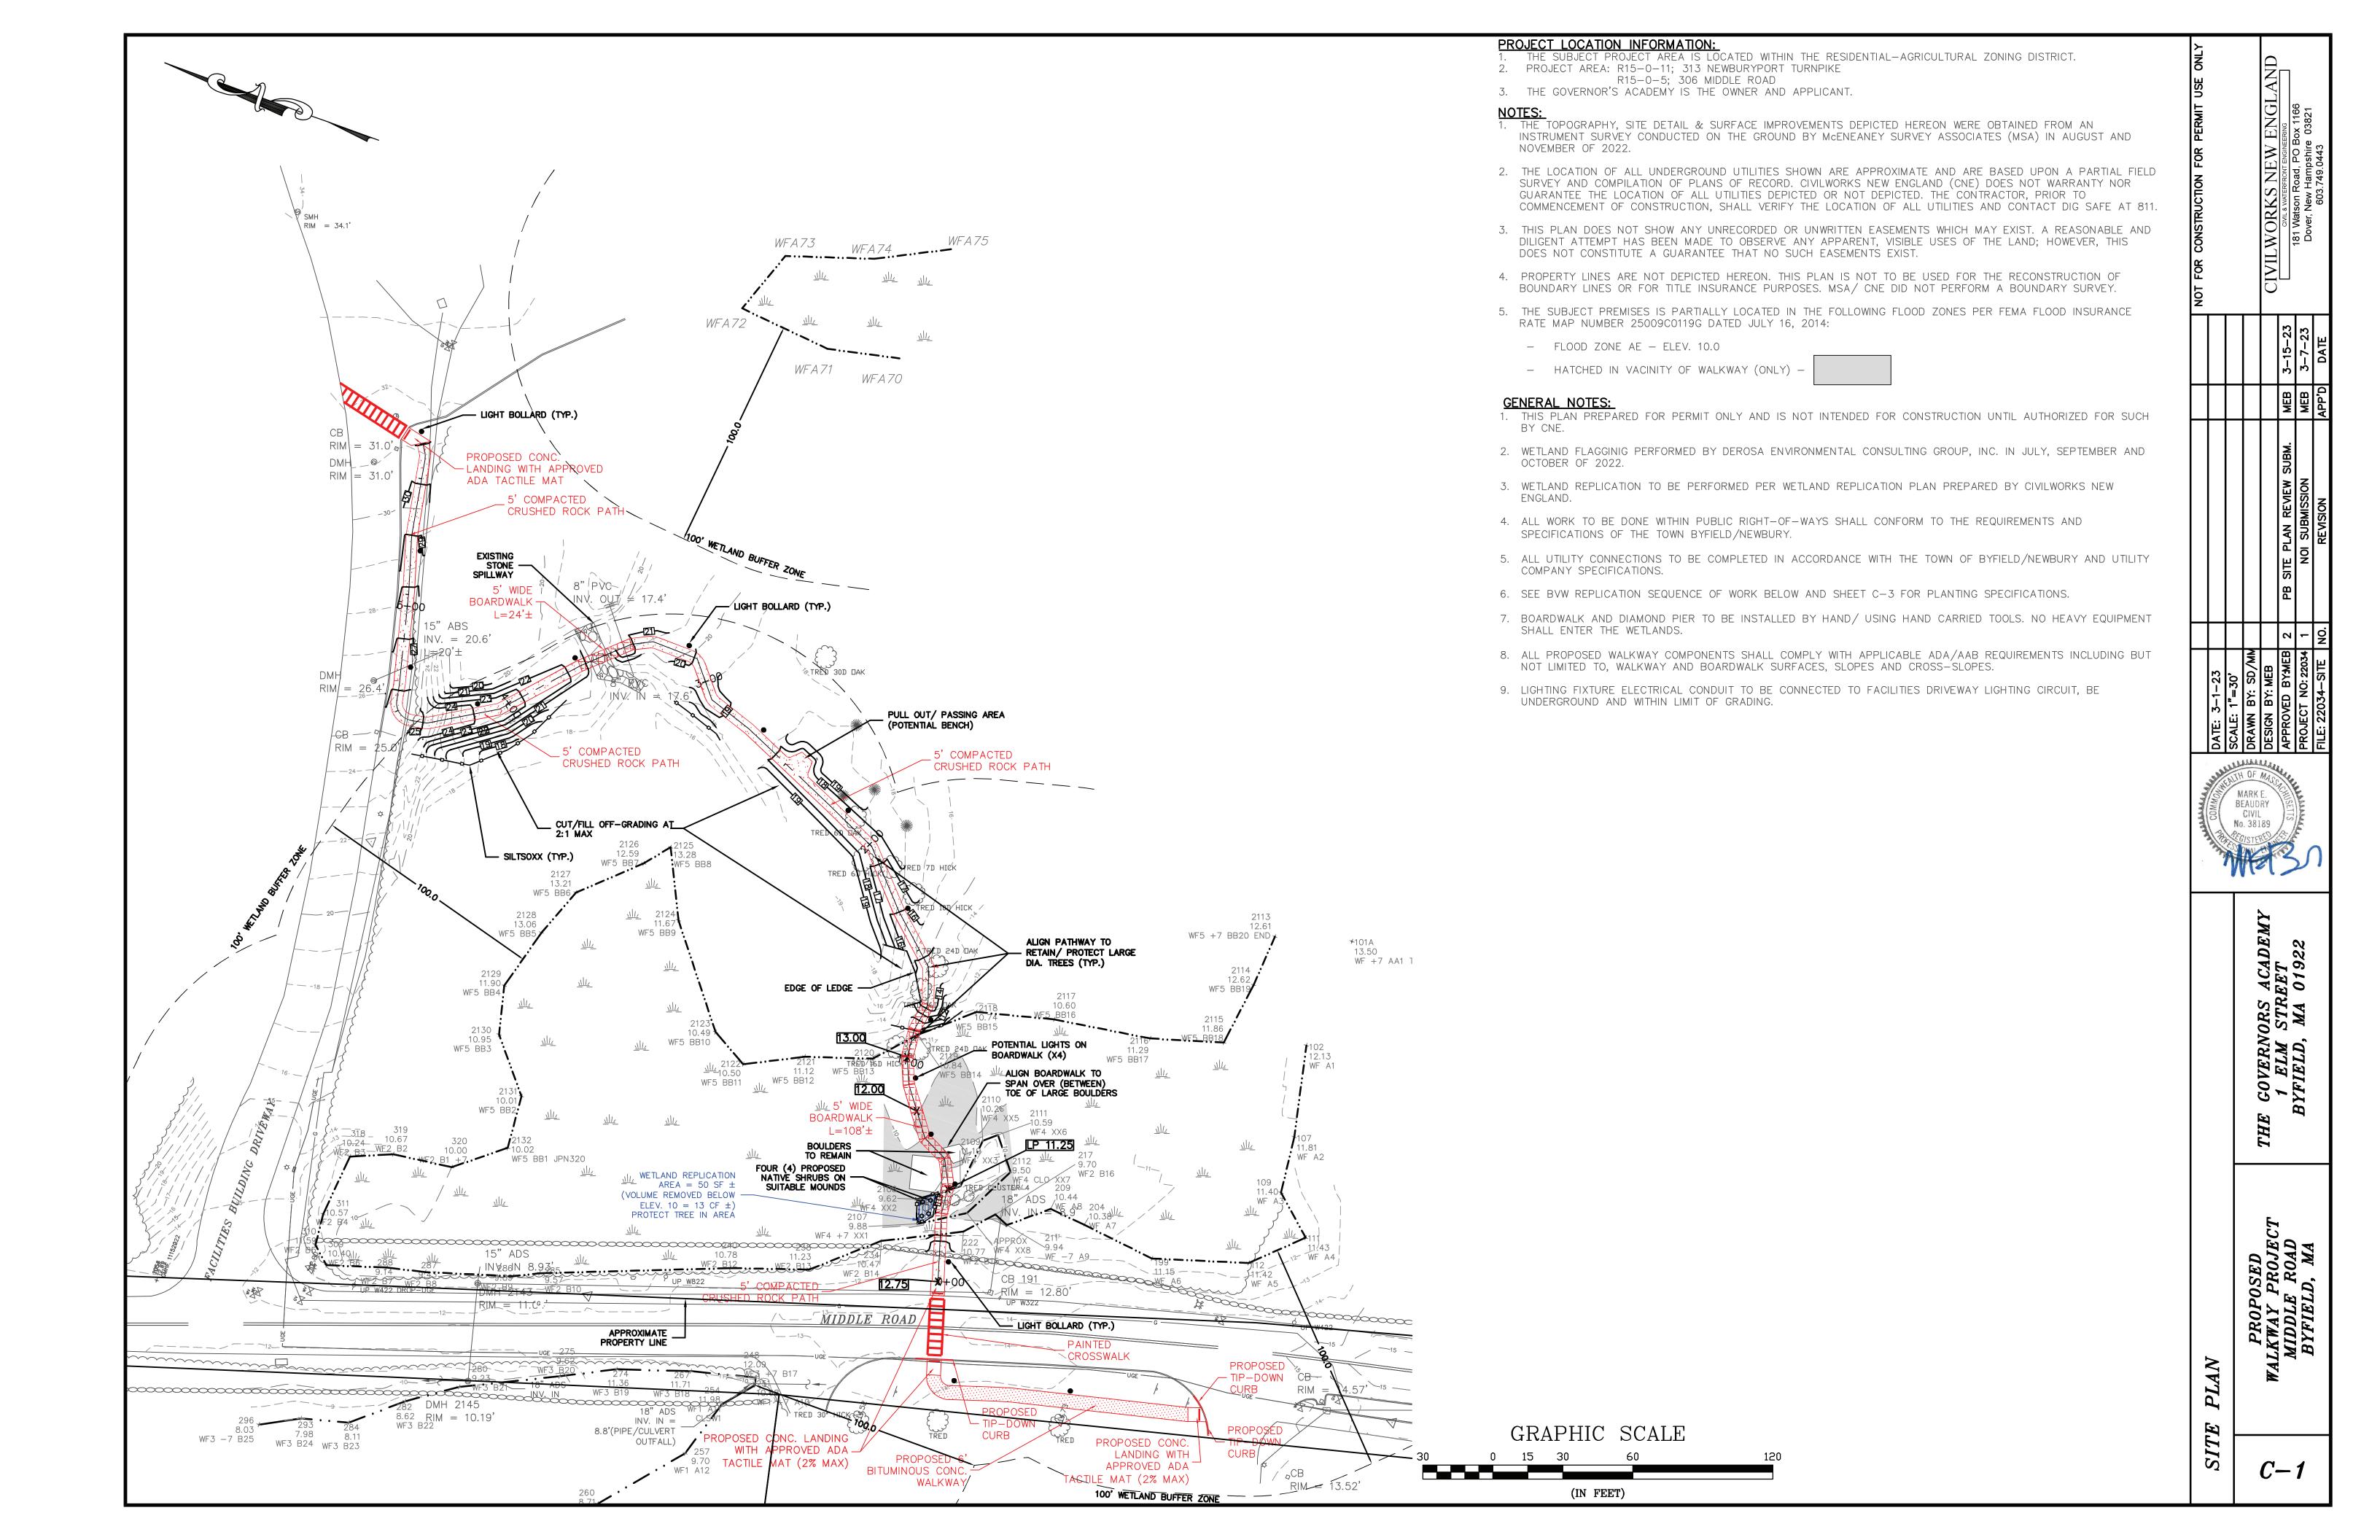

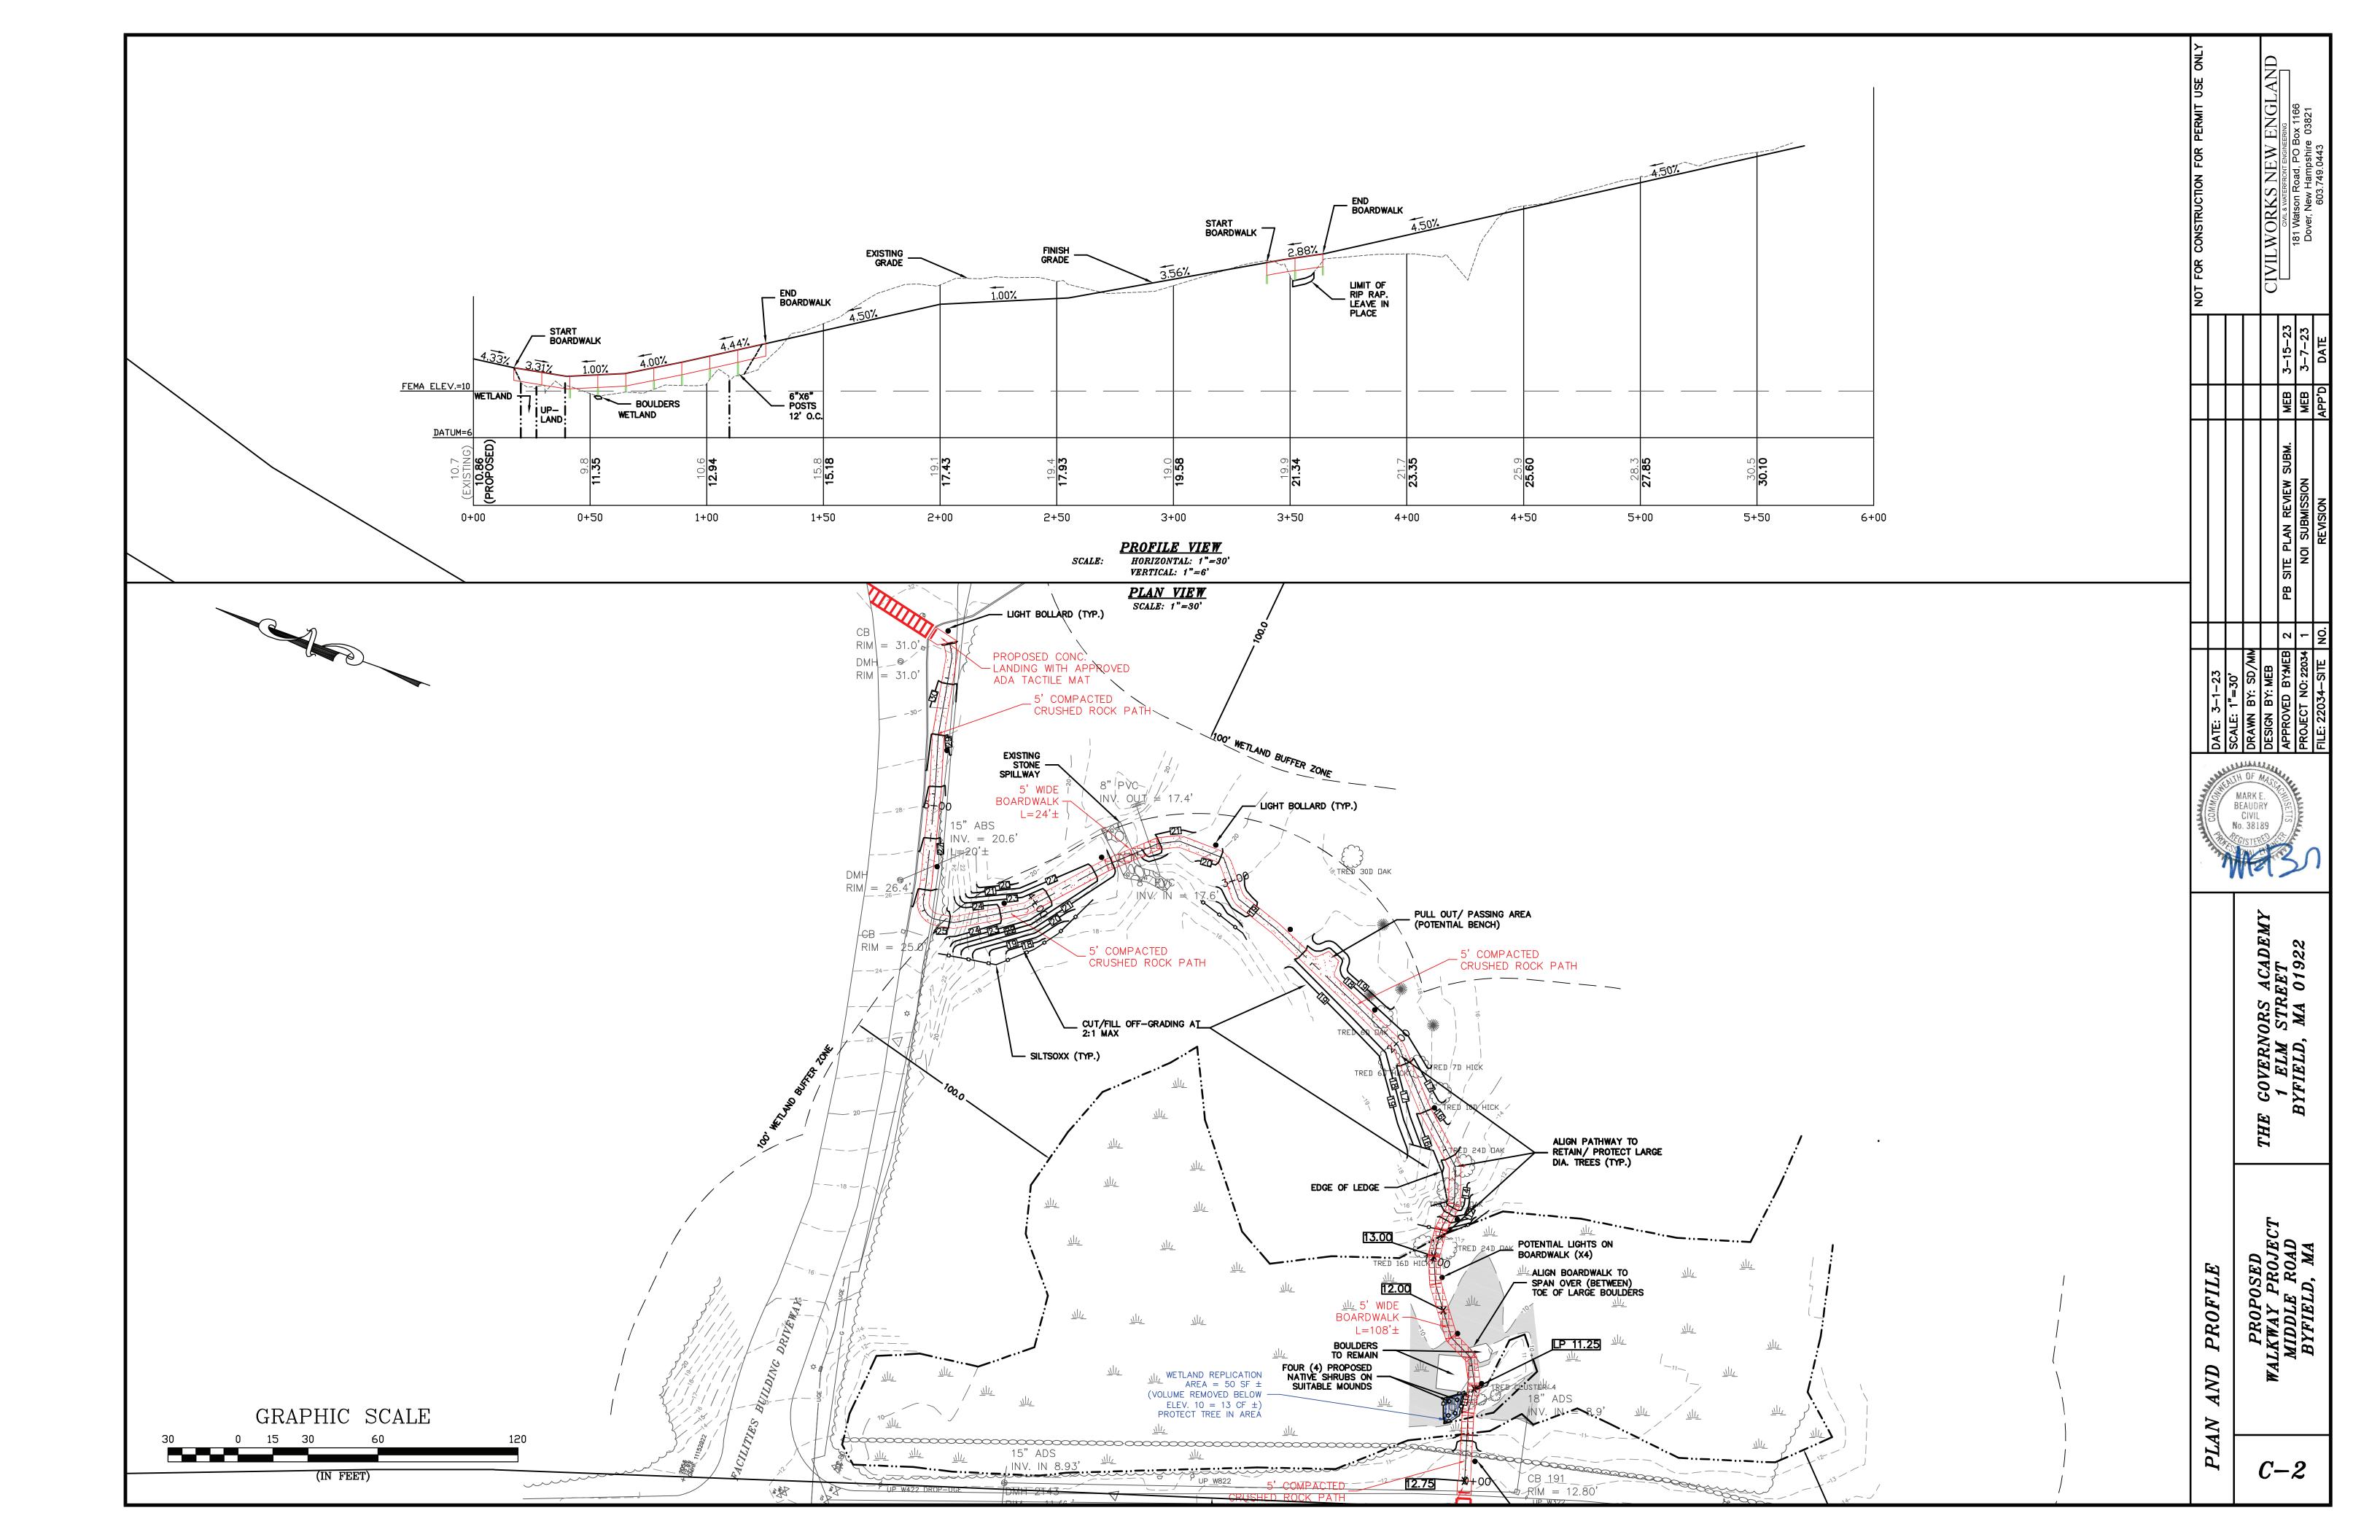

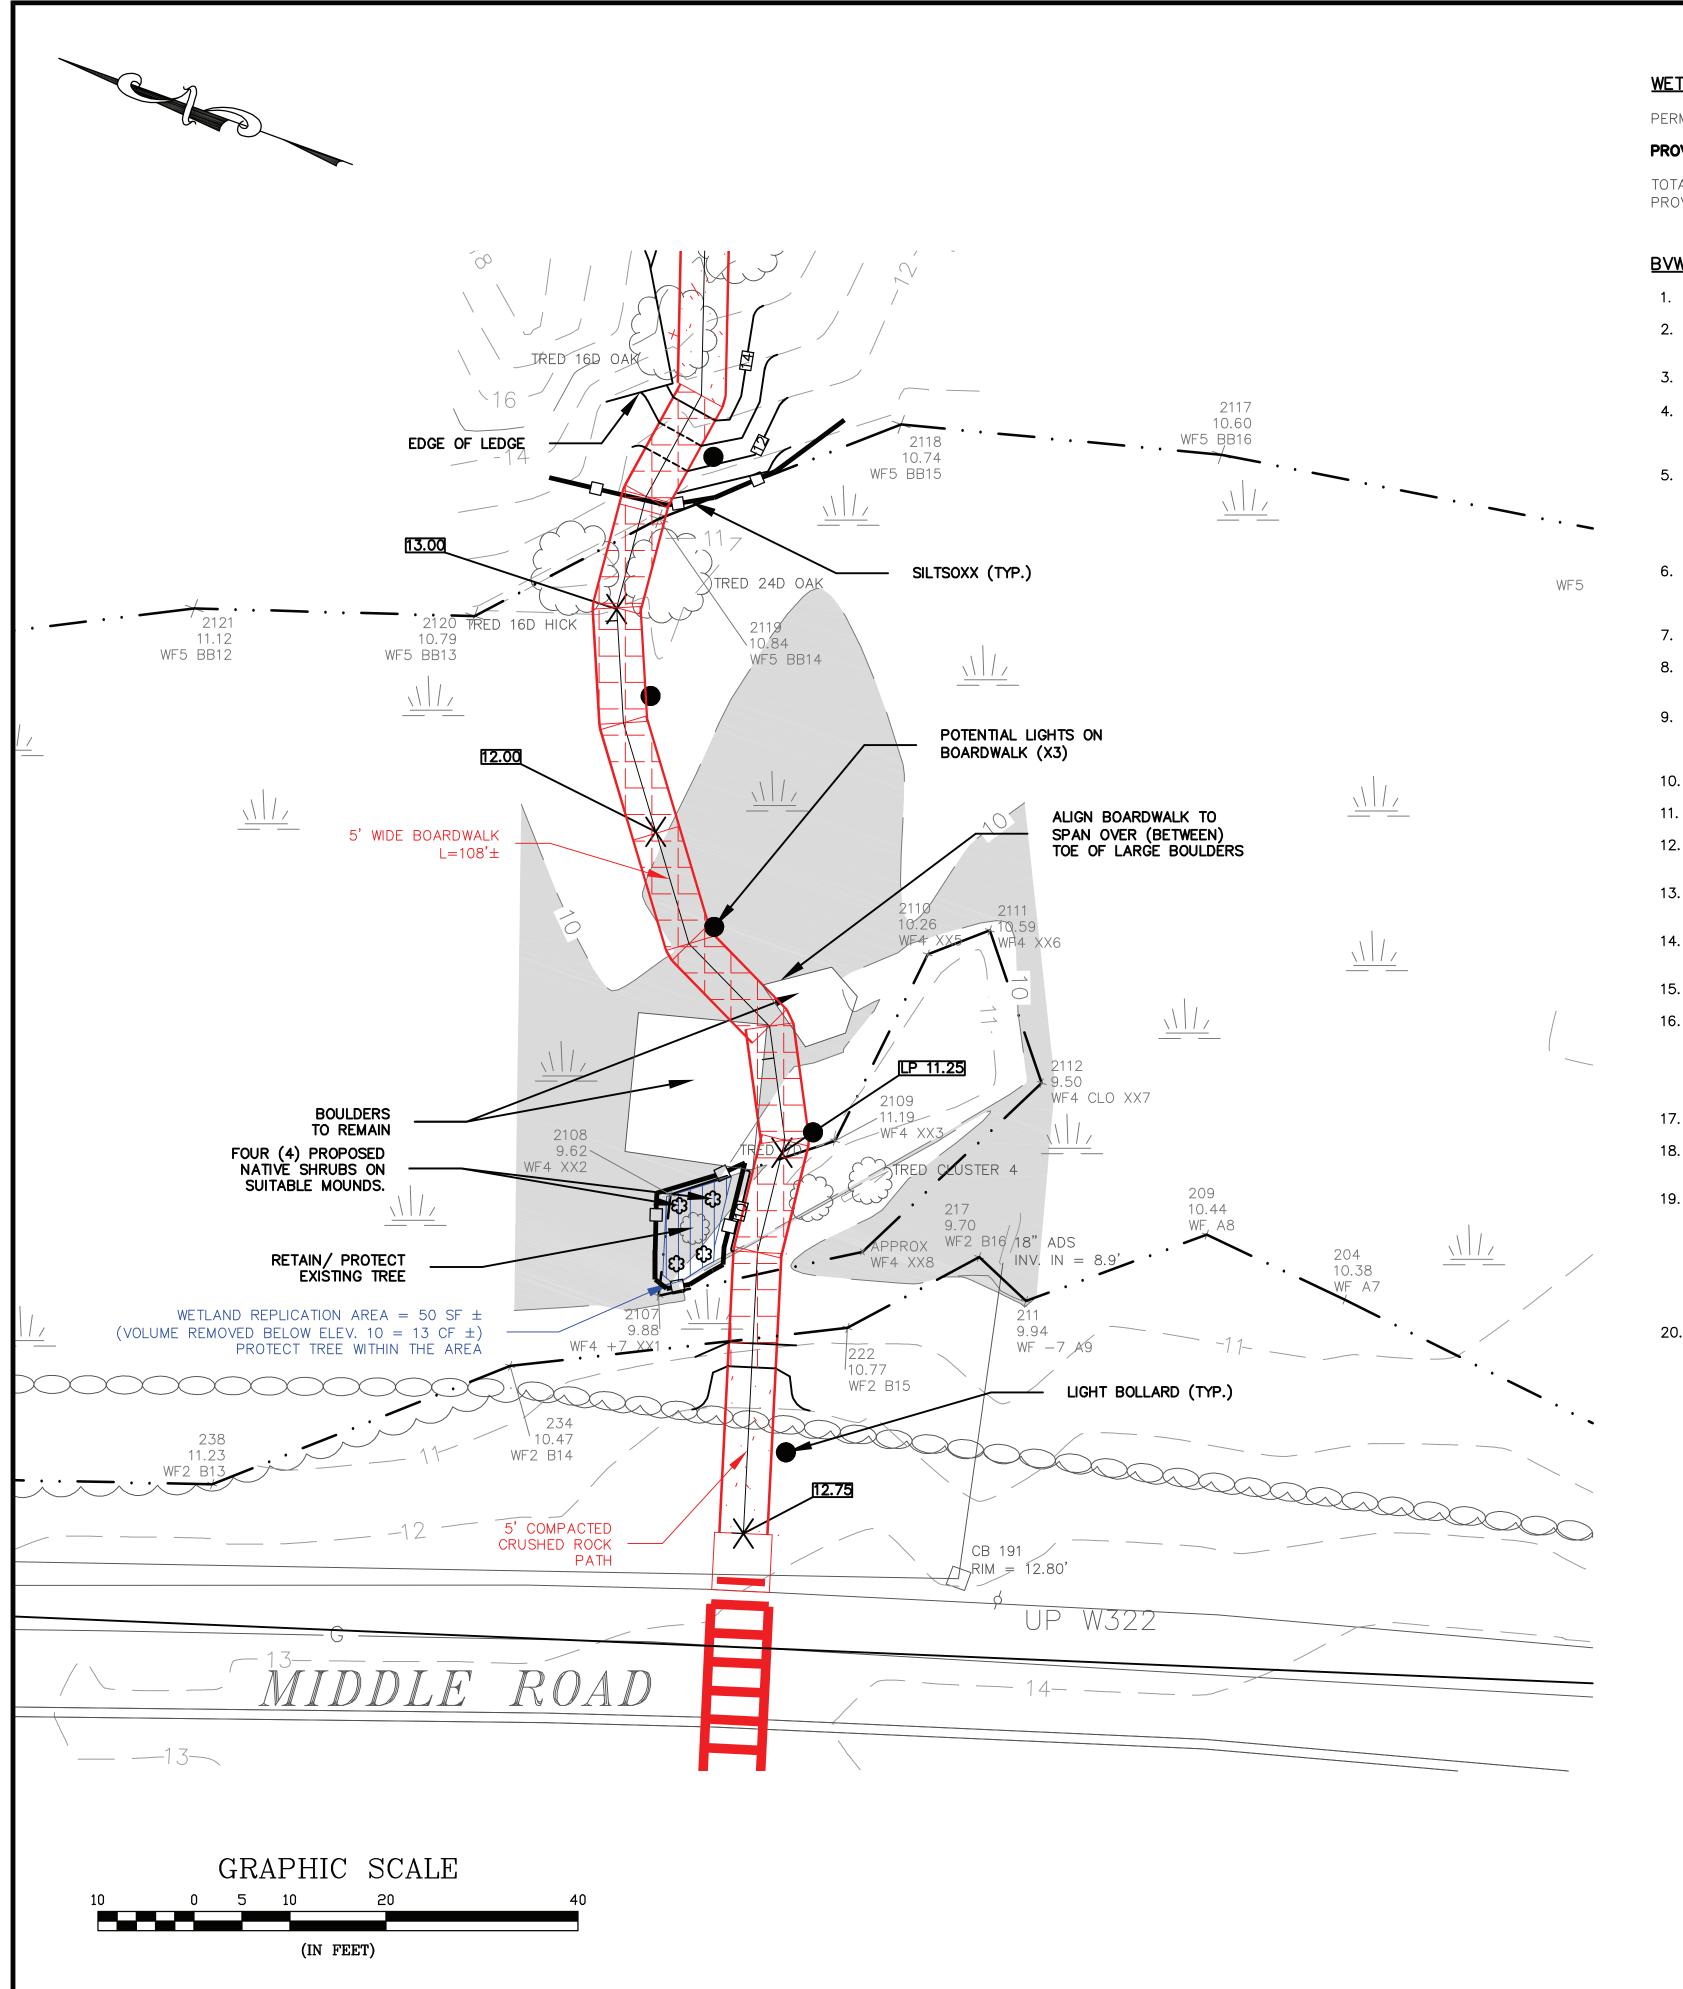

WETLAND REPLICATION COMPENSATORY FLOOD STORAGE CALCULATIONS:

= 14 FOOTING POSTS X 1 SF/FOOTING PERMANENT WETLAND ALTERATION


PROVIDE MINIMUM OF 28 SF WETLAND REPLICATION

TOTAL FLOODPLAIN FILL = 8 POSTS (CONSERVATIVE) EXTEND BELOW FEMA ELEV. 10. ALLOW 0.25 CF/POST = 2 CF (CONSERVATIVE) PROVIDE MINIMUM OF 2 CF COMPENSATORY VOLUME (CUT) IN WETLAND REPLICATION AREA. (BELOW ELEV. 10)

BVW REPLICATION SEQUENCE OF WORK:

- 1. BVW FLAGS SHALL BE MAINTAINED DURING THE IMPLEMENTATION OF THE BVW REPLICATION AND THE REQUIRED MONITORING PERIOD.
- 2. PRIOR TO THE COMMENCEMENT OF WORK ON THE BVW REPLICATION AREA A PRE-CONSTRUCTION MEETING SHALL TAKE PLACE BETWEEN THE CONTRACTOR AND AN APPROVED WETLAND SCIENTIST.
- 3. THE PERIMETER OF THE REPLACEMENT AREA WILL BE FIELD MEASURED AND MARKED WITH FLAGGING OR STAKES.
- 4. EQUIPMENT/EXCAVATOR SHALL IN NO SITUATION ENTER BVW AREA. EXCAVATOR SHALL MOBILIZE ON THE UPLAND AREA OF THE BVW ON THE MIDDLE ROAD SIDE, REACHING OVER THE BVW AREA TO THE WETLAND REPLICATION AREA. CLEARED VEGETATION CAN BE REUSED AS TEMPORARY MATTING IF NECESSARY.
- EROSION CONTROLS SHALL BE INSTALLED BETWEEN THE REPLICATION AREA AND INDIGENOUS BVW TO REMAIN UNALTERED. TO PROVIDE A BLENDED TRANSITION FROM THE UNALTERED BVW TO THE REPLICATION AREA EXCAVATION WILL NEED TO OCCUR ALONG THE DELINEATED BVW. THEREFOR, EROSION CONTROL WILL BE INSTALLED IMMEDIATELY FOLLOWING THE PERIMETER EXCAVATION AND PRIOR TO ADDITIONAL EXCAVATION OF THE BVW REPLICATION AREA. TO PRESERVE EXISTING TREE, EXCAVATION WILL BE VERY GRADUAL, AVOIDING ROOT SYSTEMS, PRIOR TO EXCAVATING DEEPER.
- 6. EXISTING WOODY VEGETATION FROM THE BVW REPLICATION AREA WILL BE REMOVED WITH THE EXCEPTION OF THE TREE. MATURE TREES WILL BE AVOIDED FOR ACCESS. SAPLINGS AND SHRUBS CAN BE CUT TO PROVIDE ACCESS. WITHIN THE BVW REPLICATION AREA ALL WOODY AND HERBACEOUS VEGETATION WILL BE REMOVED.
- 7. THE A-HORIZON AND O-HORIZON WITHIN THE BVW REPLICATION AREA WILL BE REMOVED AND STOCKPILED FOR FUTURE USE, IF ANY.
- 8. ONCE THE A AND O HORIZONS HAVE BEEN REMOVED THE SUBSOILS WILL BE EXCAVATED TO OBTAIN THE REQUISITE DEPTH. SUBSOILS WILL BE EXCAVATED TO MATCH THE EXISTING, ADJACENT BVW GRADES.
- 9. THE SOILS WILL THEN BE OVER-EXCAVATED AT VARIED DEPTHS (APPROXIMATELY O TO 10 INCHES) TO OBTAIN THE APPROPRIATE HYDROPERIOD AND MICROTOPOGRAPHY. HUMMOCKS WILL BE ESTABLISHED TO PROVIDE SUITABLE PLANTING MOUNDS FOR 4 NATIVE
- 10. EXCAVATED SUBSOILS WILL BE STOCKPILED ON SITE FOR FUTURE USED IN CONSTRUCTION, IF DEEMED APPROPRIATE.
- 11. ALL EXCESS EXCAVATED SUBSOILS WILL BE TRUCKED OFF-SITE OR BROUGHT TO AN UPLAND AREA OUTSIDE OF WPA JURISDICTION.
- 12. THE EXCAVATED BVW REPLICATION AREA SHALL BE INSPECTED BY AN APPROVED WETLAND SCIENTIST PRIOR TO THE PLACEMENT OF WETLAND SOILS.
- 13. ONCE THE BVW REPLICATION AREA HAS BEEN OVER EXCAVATED EXPOSED SOILS WILL BE LOOSENED TO RELIEVE SOIL COMPACT. THE AREA WILL THEN BE COVERED WITH 8 TO 12-INCHES OF THE WETLAND SOIL.
- 14. WETLAND SOILS MAY BE SOURCED FROM AGRESOURCE, INC., IPSWICH, MA OR A SIMILAR ALTERNATIVE VENDOR THAT IS SUBJECT TO THE APPROVAL FROM THE CONSERVATION COMMISSION OR CONSERVATION COMMISSION AGENT.
- 15. AFTER THE SOILS HAVE BEEN PLACED AND FINE GRADED THE BVW REPLICATION AREA WILL BE SEEDED AND PLANTED.
- 16. TO ESTABLISH AN HERBACEOUS GROUND COVER AS WELL AS WOODY VEGETATION, THE BVW REPLICATION AREA WILL BE SEEDED WITH A NATIVE WET AND SEED MIX, NEW WETLAND PLANTS WETMIX OR SIMILAR, AT THE NURSERY RECOMMENDED APPLICATION RATE. THE BVW REPLICATION AREA SHALL BE PLANTED AS SPECIFIED BY THE BVW REPLICATION PLANTING LIST PRESENTED BELOW. THE NUMBER OF PLANTS HAS BEEN BASED ON AN OVERALL DENSITY OF SHRUBS AT 6-FOC. A TOTAL OF 4 NATIVE SHRUBS SHALL BE PLANTED IN NATURALISTIC CLUMPS. EATURES (I.E. STUMPS AND WOODY DEBRIS) SHALL BE PLACED PRIOR TO PLANTING.
- 17. A VISUAL INSPECTION OF THE NEARBY BVW WILL BE MADE AND ANY ADDITIONAL INVASIVE PLANT SPECIES WILL BE REMOVED BY HAND.
- 18. DISTURBED SOILS WITHIN THE ADJACENT BUFFER ZONE WILL BE GRADED TO ACHIEVE STABLE SIDE-SLOPES AND SEEDED WITH A NON-INVASIVE CONSERVATION MIX AND MULCHED WITH STRAW.
- 19. THE BVW REPLICATION AREA SHALL BE MONITORED BY AN APPROVED WETLAND SCIENTIST FOR TWO CONSECUTIVE GROWING SEASONS BEGINNING ON THE FIRST FULL GROWING SEASON AFTER THE IMPLEMENTATION OF THE RESTORATION WORK. THE WETLAND SCIENTIST SHALL SUBMIT A YEARLY MONITORING REPORT WITH COLOR PHOTOGRAPHS TAKEN FROM ESTABLISHED REFERENCED POINT TO THE BYFIELD/NEWBURY CONSERVATION COMMISSION. IN THE EVENT THAT A BVW REPLICATION AREA IS NOT IN COMPLIANCE WITH THE APPROVED PLAN AND 310 CMR 10.55(4), THE WETLAND SCIENTIST SHALL INCLUDE A "CORRECTIVE PLAN OF ACTION" WITH THE YEARLY MONITORING REPORT. THE CORRECTIVE PLAN OF ACTION SHALL BE IMPLEMENTED FOLLOWING REVIEW AND APPROVAL BY THE BYFIELD/ NEWBURY CONSERVATION COMMISSION.
- 20. REFER TO WETLAND REPLICATION AREA DETAIL AND ENLARGEMENT ON SHEET C-4.

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				3-15-23	3-7-23	DATE	
				MEB	MEB	APP'D	
				PB SITE PLAN REVIEW SUBM.	NOI SUBMISSION	REVISION	
				2	1	NO.	
DAIE: 3-1-23	SCALE: 1"=10'	DRAWN BY: SD/MM	DESIGN BY: MEB	APPROVED BY:MEB	PROJECT NO: 22034	FILE: 22034-SITE NO.	
NIH OF MAC							

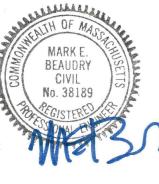

REPLICATION

WETLAND

DESCRIPTION

THE INTENT OF THIS PLAN IS TO SHOW THE IMPROVEMENTS ASSOCIATED WITH THE CONSTRUCTION OF CRUSHED ROCK WALKWAY AND BOARDWALK. <u>DISTURBED AREA</u>

±7,080 SQUARE FEET OF DISTURBANCE

±82 FEET OF BOARDWALK OVER WETLAND

INSTALLATION, MAINTENANCE AND INSPECTION PROCEDURES OF EROSION

AND SEDIMENT CONTROLS

- 1. EPA NOTICE OF INTENT IS NOT REQUIRED FOR THIS SITE.
- 2. PLACE TEMPORARY EROSION AND SEDIMENT CONTROL BMP'S PRIOR TO EARTH MOVING ACTIVITIES.
- 3. ALL EROSION CONTROL AND PERIMETER CONTROLS SHALL BE INSTALLED PRIOR TO COMMENCING EARTH MOVING OPERATIONS.
- 4. REFER TO REPLICATION NOTES ON C-3 FOR MORE INFORMATION.
- 5. REGRADE SITE TO SUBGRADE.
- 6. INSTALL UNDERGROUND ELECTRICAL UTILITIES AND FOUNDATIONS FOR BOARDWALK AND LIGHT BOLLARDS.
- 7. PLACE GRAVELS AND FINE GRADE.
- 8. STABILIZE, PATHWAY WITHIN 72 HOURS OF ACHIEVING FINISHED GRADE.
- 9. ALL CUT AND FILL SLOPES SHALL BE LOAMED AND SEEDED (AS APPLICABLE) WITHIN 72 HOURS OF ACHIEVING FINISH GRADE.
- 10. ALL EROSION CONTROL MEASURES SHALL BE INSPECTED AT LEAST WEEKLY AND AFTER EVERY 1/4" OF RAINFALL.
- 11. IN ALL CASES THE SMALLEST PRACTICAL AREA SHALL BE DISTURBED DURING CONSTRUCTION AND IN NO CASE SHALL EXCEED 1 ACRES AT ANY ONE TIME BEFORE DISTURBED AREAS ARE STABILIZED. ALL DISTURBED AREAS SHALL BE STABILIZED WITHIN 45 DAYS OF INITIAL DISTURBANCE.
- 12. WHEN ALL SITE WORK IS COMPLETE AND ALL DISTURBED AREAS ARE STABILIZED REMOVE ALL TEMPORARY EROSION CONTROL MEASURES.
- 13. AN AREA SHALL BE CONSIDERED STABLE IF ONE OF THE FOLLOWING HAS OCCURRED

 A RASE COURSE CRAVELS HAVE BEEN INSTALLED IN AREAS TO BE DAVED(BIT CONC. SIDEWALK) OR CRUSHD ROCK IN WALKWAYS AREA
- A. BASE COURSE GRAVELS HAVE BEEN INSTALLED IN AREAS TO BE PAVED(BIT. CONC. SIDEWALK) OR CRUSHD ROCK IN WALKWAYS AREA.
- B. A MINIMUM OF 85% VEGETATED GROWTH HAS BEEN ESTABLISHED
 C. A MINIMUM OF 3" OF NON—EROSIVE MATERIAL SUCH AS STONE OR RIP—RAP HAS BEEN INSTALLED; OR
- D. EROSION CONTROL BLANKETS HAVE BEEN PROPERLY INSTALLED

MAINTENANCE OF

EROSION & SEDIMENT CONTROL FACILITIES

THE PROJECT CONTRACTOR IS RESPONSIBLE FOR THE MAINTENANCE OF ALL FACILITIES DURING

CONSTRUCTION AND THE PROPERTY OWNER IS RESPONSIBLE AFTER CONSTRUCTION IS COMPLETE.


1. SILT BARRIERS

A. SEQUENCE OF INSTALLATION

- SEDIMENT BARRIERS SHALL BE INSTALLED PRIOR TO ANY SOIL DISTURBANCE OF THE CONTRIBUTING DRAINAGE AREA ABOVE THEM.

 B. MAINTENANCE
 - a. CHECK DAMS AND SEDIMENT BARRIERS SHALL BE INSPECTED IMMEDIATELY AFTER EACH RAINFALL AND AT LEAST DAILY DURING PROLONGED RAINFALL. THEY SHALL BE REPAIRED IF THERE ARE ANY SIGNS OF EROSION OR SEDIMENTATION BELOW THEM. ANY REQUIRED REPAIRS SHALL BE MADE IMMEDIATELY. IF THERE ARE SIGNS OF UNDERCUTTING AT THE CENTER OR THE EDGES, OR IMPOUNDING OF LARGE VOLUMES OF WATER BEHIND THEM, SEDIMENT BARRIERS SHALL BE REPLACED WITH A TEMPORARY CHECK DAM.
- b. SHOULD THE BARRIER DECOMPOSE OR BECOME INEFFECTIVE PRIOR TO THE END OF THE EXPECTED USABLE LIFE AND THE
- BARRIER STILL IS NECESSARY, THE FABRIC SHALL BE REPLACED PROMPTLY. c. SEDIMENT DEPOSITS SHOULD BE REMOVED AFTER EACH STORM EVENT. THEY MUST BE REMOVED WHEN DEPOSITS REACH
- APPROXIMATELY ONE THIRD (1/3) THE HEIGHT OF THE BARRIER.

 d. ANY SEDIMENT DEPOSITS REMAINING IN PLACE AFTER THE SILT FENCE OR FILTER BARRIER IS NO LONGER REQUIRED SHALL BE DRESSED TO CONFORM WITH THE EXISTING GRADE, PREPARED AND SEEDED.

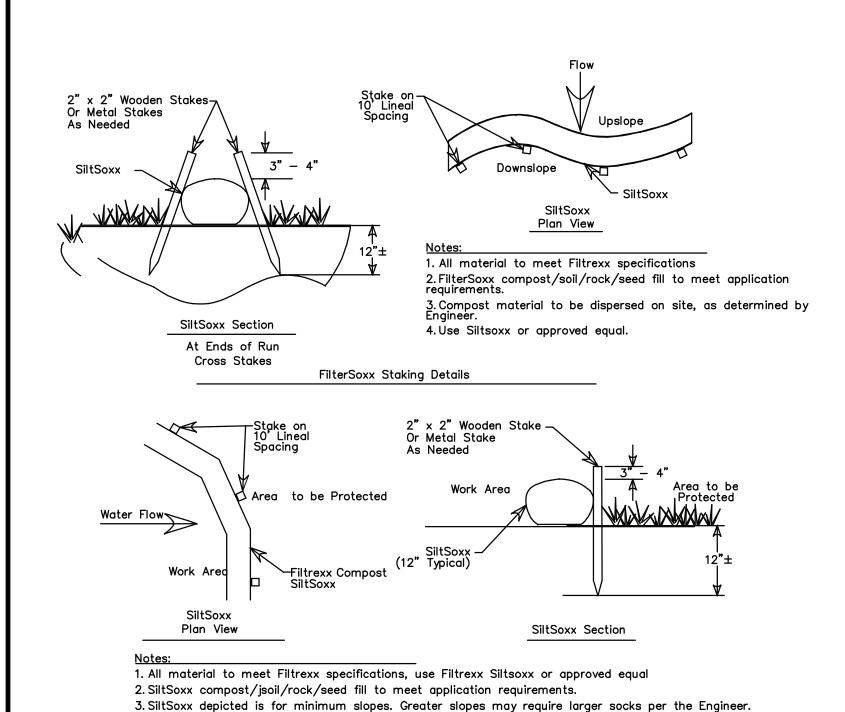

4. Compost material to be dispersed on site, as determined by Engineer.

SILTSOXX DETAILS
NOT TO SCALE

WETLAND REPLICATION AREA ENLARGEMENT
SCALE: 1"=4"

2108

9.62

WF4 XX2


PROPOSED SILTSOXX

RETAIN / PROTECT EXISTING TREE

WETLAND REPLICATION AREA = $50 \text{ SF} \pm$

PROTECT TREE WITHIN THE AREA

(VOLUME REMOVED BELOW ELEV. $10 = 13 \text{ CF } \pm$)

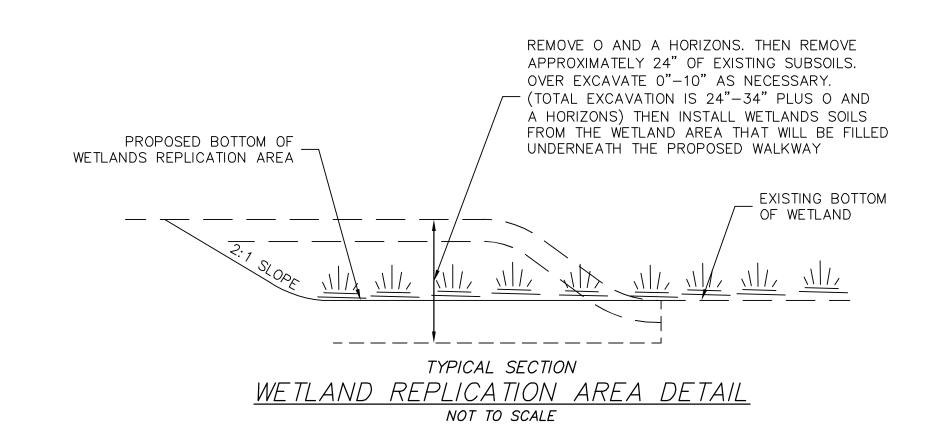


FOUR (4) PROPOSED NATIVE SHRUBS ON SUITABLE MOUNDS.



WF4 XX8

				PB SITE PLAN REVIEW SU	NOI SUBMISSION	REVISION	
				2	1	NO.	
DAIE: 3-1-23	SCALE: DETAILS	DRAWN BY: SD/MM	DESIGN BY: MEB	APPROVED BY:MEB	PROJECT NO: 22034	FILE: 22034-SITE	
MARK E. BEAUDRY CIVIL NO 38189							

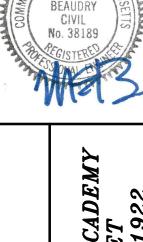

THE GOVERNORS AC 1 ELM STREES

CONTROL

SEDIMENT

EROSION

PROPOSED
'ALKWAY PROJECT
MIDDLE ROAD
RYEIFIN MA

C-4

